

THE PLAN

ARCHITECTURE & TECHNOLOGIES IN DETAIL



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Wenn Design & Funktionalität aufeinander treffen ...

When design meets functionality ...

La Serenissima (Office Morgan Stanley) | Milan

Interview mit Studio Park Associati

Interview with Studio Park Associati



Architect Marco Panzeri



Architect Davide Pojaga

Panzeri & Pojaga über La Serenissima:

Uns von Park Associati war es vor allem wichtig, eine flexible Decke für den Investor zu finden. Wir haben uns bei der Suche nach einer derartigen Lösung bewusst gegen eine vertikale Gipskarton-Abschottung und für den Einsatz von horizontaler Abschottung in den Bandraster-Kassetten entschieden. Durch dieses System wird eine vollkommene Flexibilität unter den Bandrastern gewährleistet, wodurch die Raumauftteilung beliebig variiert werden kann.

Außerdem haben wir beim Projekt La Serenissima darauf geachtet, die Randbereiche möglichst optimal zu verarbeiten. FURAL hat dafür spezielle Passplatten gefertigt, die dann vor Ort nur noch montiert werden mussten. So konnte für den gesamten Bereich des Bürogebäudes eine horizontale Abschottung gegen den Längsschall erreicht werden.

Ihre Erfahrung mit FURAL:

In FURAL haben wir einen äußerst kompetenten Partner gefunden, der sich in puncto Qualität und Oberflächen von den übrigen Herstellern deutlich abhebt. FURAL zeichnet sich durch ein starkes Bewusstsein für Umweltschutz und nachhaltige Ressourcennutzung aus. Dieses GreenBuilding-Bewusstsein war für uns mit ein Grund, warum wir uns auch in der Vergangenheit schon öfter für FURAL-Metaldecken entschieden haben.

Nutzen der technischen Beratung von FURAL:

Bei La Serenissima haben wir von Park Associati die komplette Planung durchgeführt. Als es um die produktionstechnischen Einzelheiten der Deckensysteme ging, hat uns FURAL bei der Detailplanung tatkräftig unterstützt. Durch die hochwertige Beratung konnten wir die Grundrisse schließlich so anpassen, dass sich seitens der Produktion erhebliche Vereinfachungen ergaben.

FURAL in einem Satz:

Die Deckensysteme von FURAL erfüllen alle ästhetischen und technischen Anforderungen für eine moderne Bürofläche, die Verwendung von FURAL-Metaldecken gestaltet sich aber vor allem durch die hervorragenden Werte bei den Lärmschutzzertifikaten als interessant.

Panzeri & Pojaga about La Serenissima:

For us at Park Associati, the primary concern was to find a flexible ceiling for the investor. While searching for such a solution, we made a conscious decision against a vertical plasterboard separation and in favour of using horizontal separations in the strip grid cassettes. This system ensures absolute flexibility between the strip grids, allowing the room layout to be modified at will.

Furthermore, we paid great attention to the La Serenissima project to finishing the edge areas as optimally as possible. FURAL manufactured special shims for this purpose, which then only needed to be installed on site. Hence, it was possible to achieve horizontal compartmentation of longitudinal sound for the entire office building.

Your experience with FURAL:

In FURAL, we have found an extremely competent partner that sets itself apart from other manufacturers in terms of quality and surfaces. FURAL is distinguished by a great appreciation of environmental conservation and sustainable resource utilisation. This "green building" awareness was one of our reasons for frequently deciding in favour of FURAL metal ceilings in the past as well.

Benefits of technical advice from FURAL:

We at Park Associati carried out all the planning for La Serenissima. When it came to the particulars concerning production of the ceiling systems, FURAL supported us actively in the detailed planning. Thanks to the high-quality advice, we were able to adapt the ground plans in such a way that substantial simplifications were achieved in production.

FURAL in one sentence:

Ceiling systems from FURAL meet all the aesthetic and technical requirements for a modern office space. However, use of FURAL metal ceilings becomes all the more attractive when the excellent values achieved in noise protection certificates are considered.



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„Wer eine Metalldecke sucht, wählt FURAL und ist begeistert.“


If you are looking for a metal ceiling and you choose FURAL, you will be delighted.“


„Architekt und FURAL - Hand in Hand zur besten Lösung.“

„Architect together with FURAL - hand in hand to the best solution.“


„Kleinigkeiten sorgen für Perfektion, aber Perfektion ist keine Kleinigkeit.“


„Small things lead to perfection, but perfection is not a small thing.“

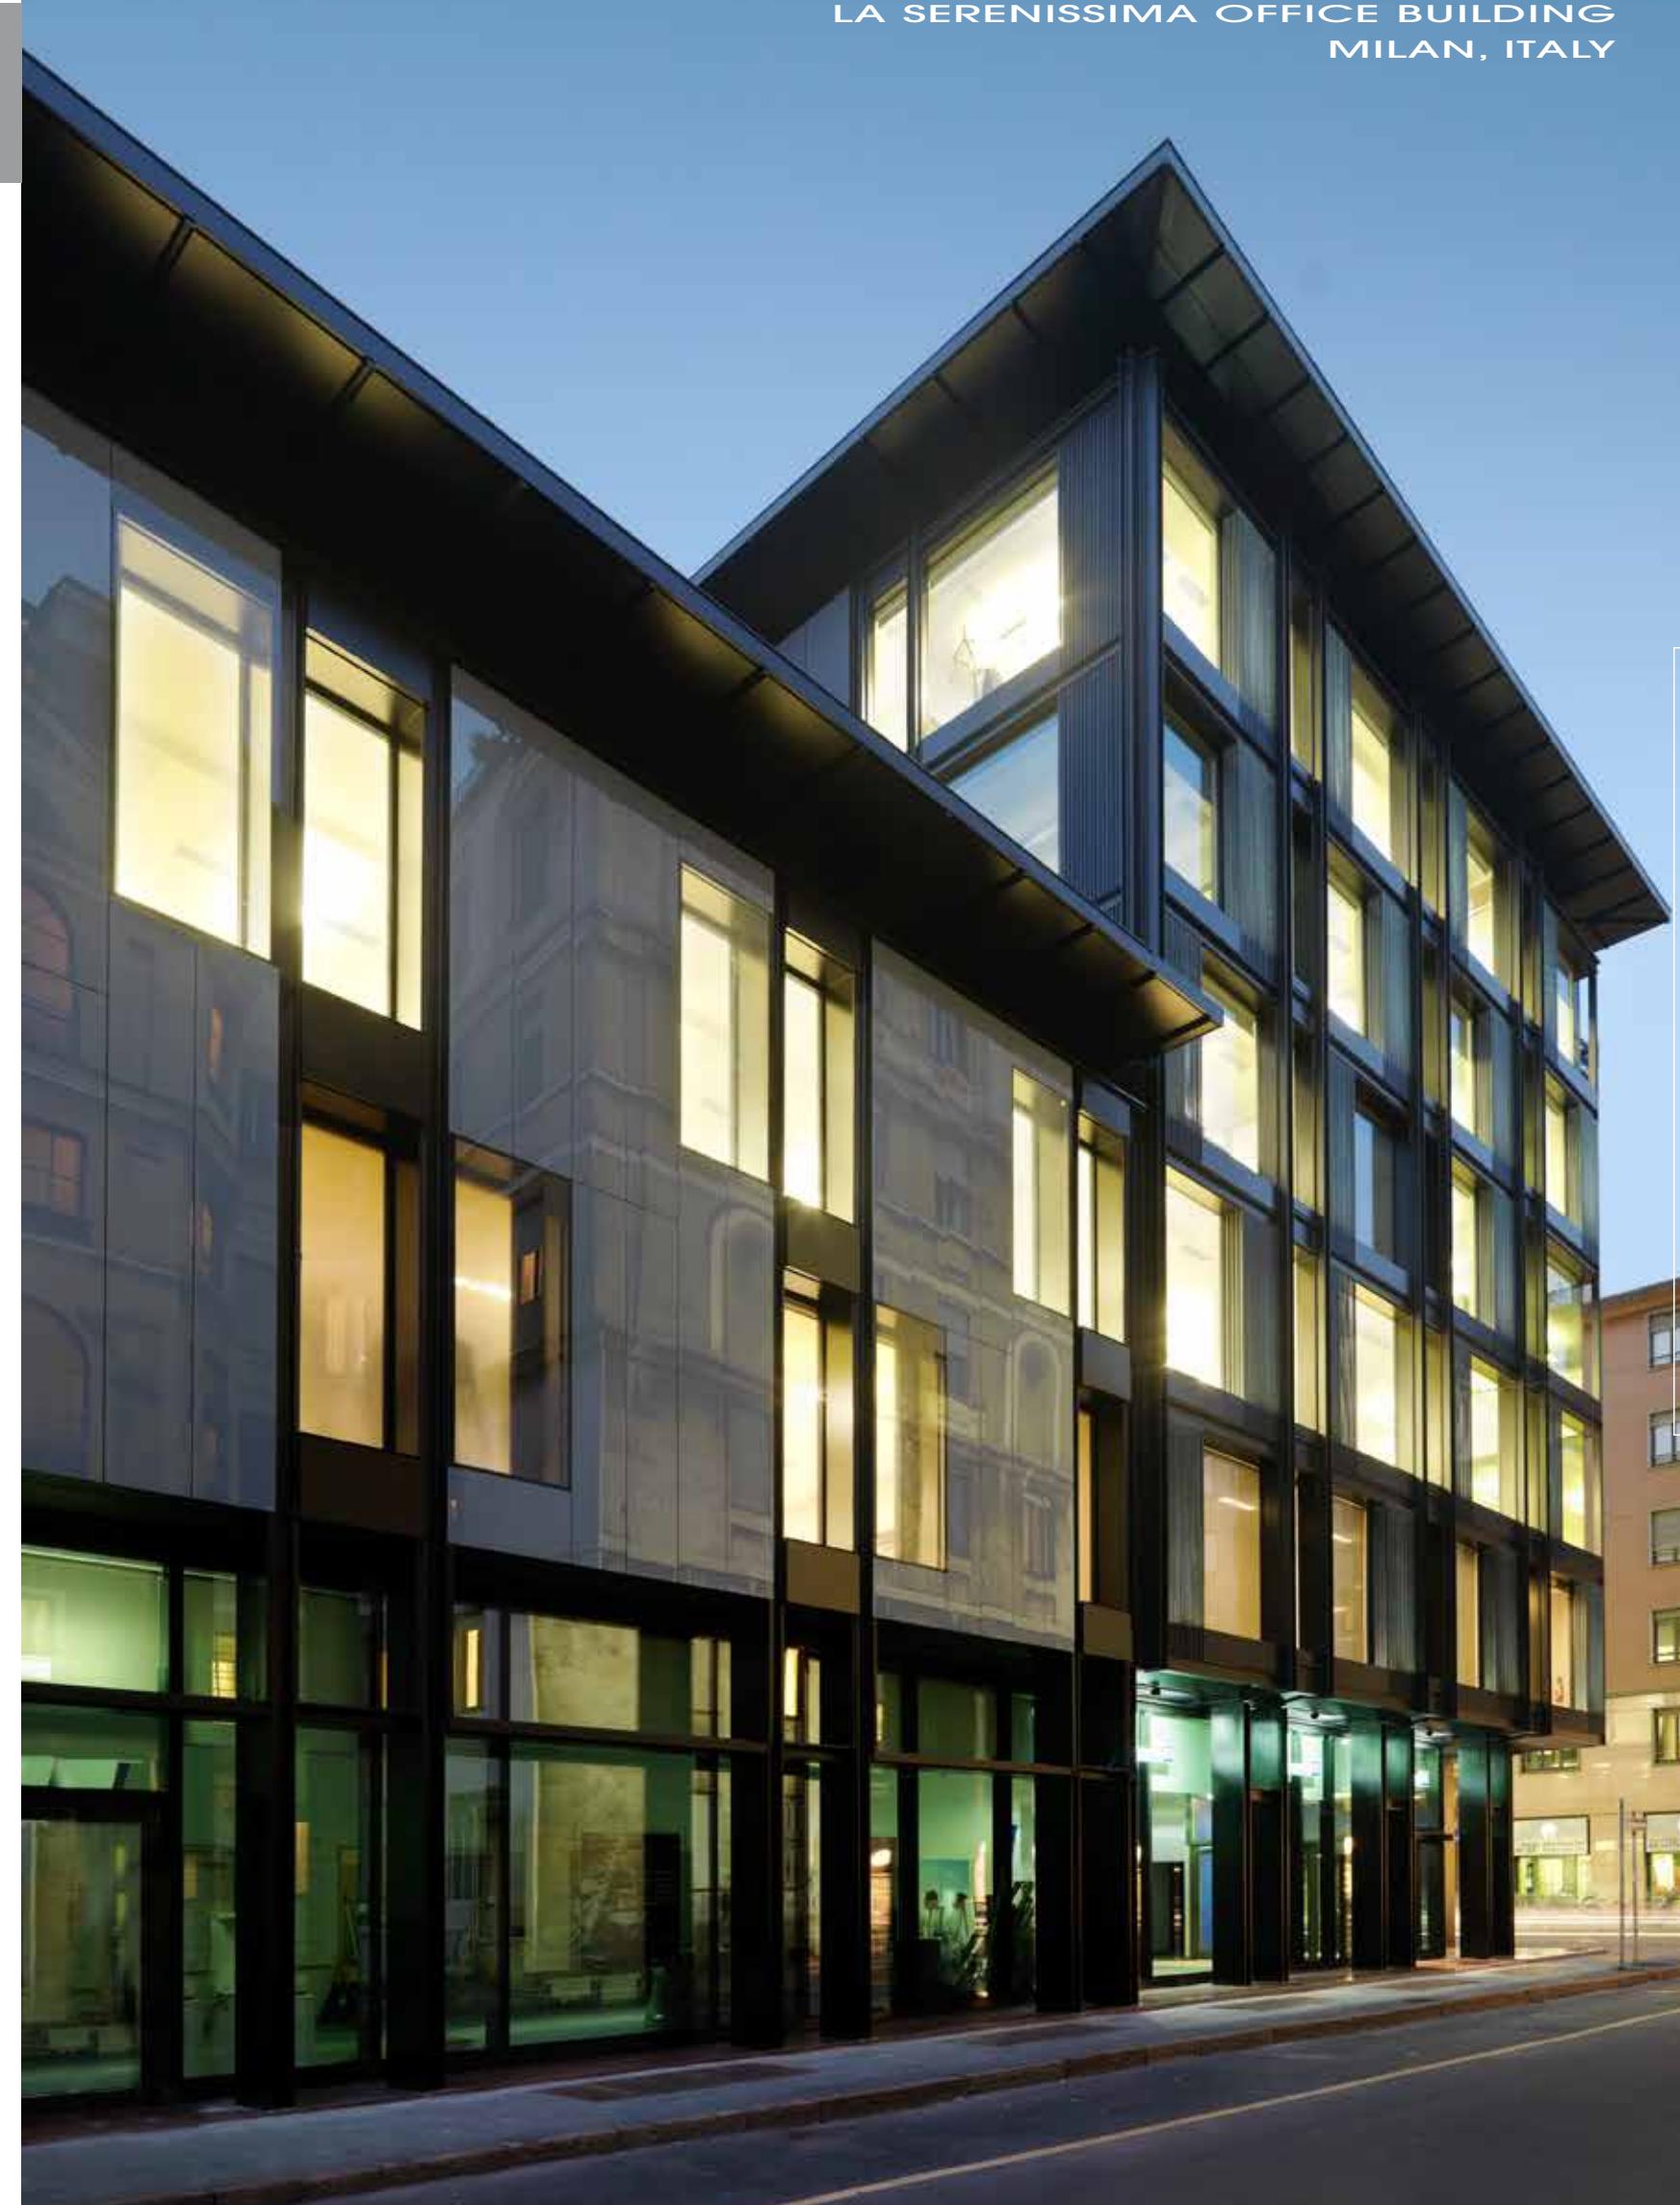

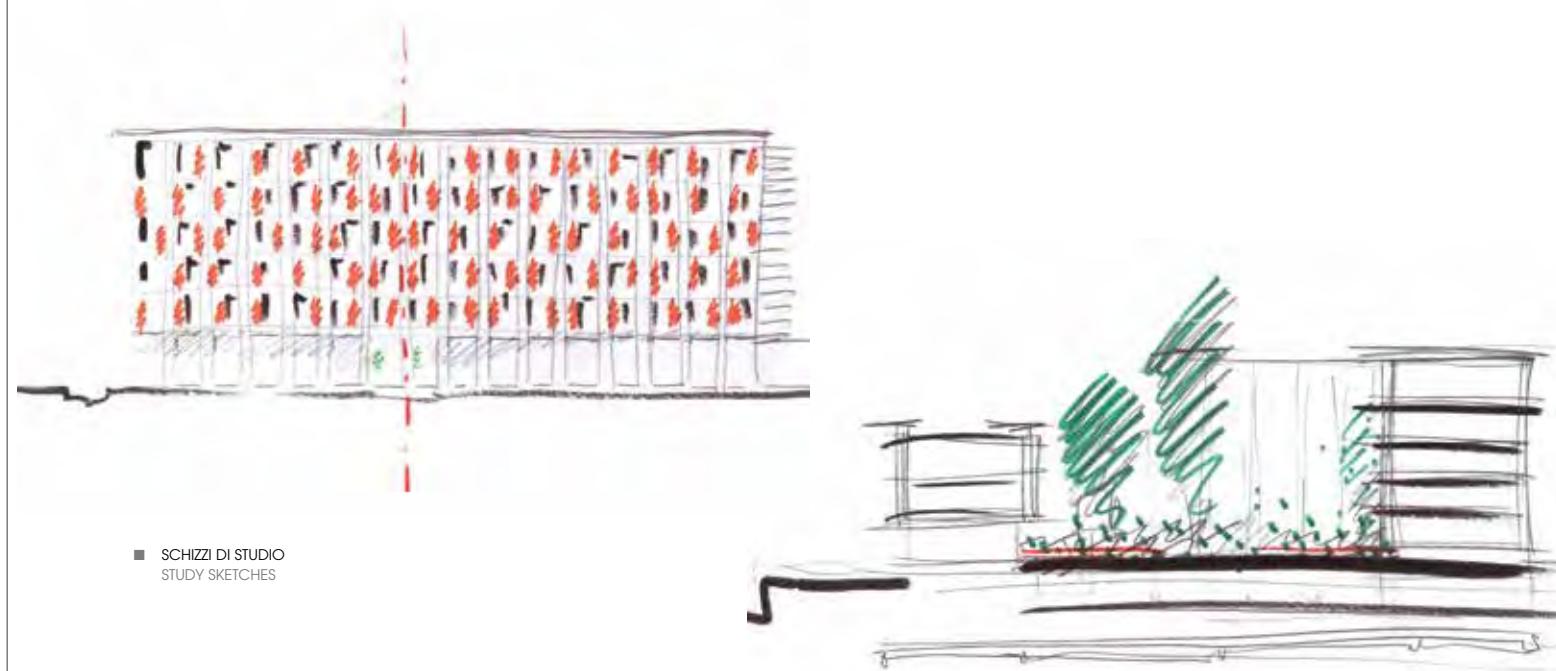

■ PROSPETTO SU VIA TURATI - SCALA 1:800
ELEVATION ON VIA TURATI - SCALE 1:800

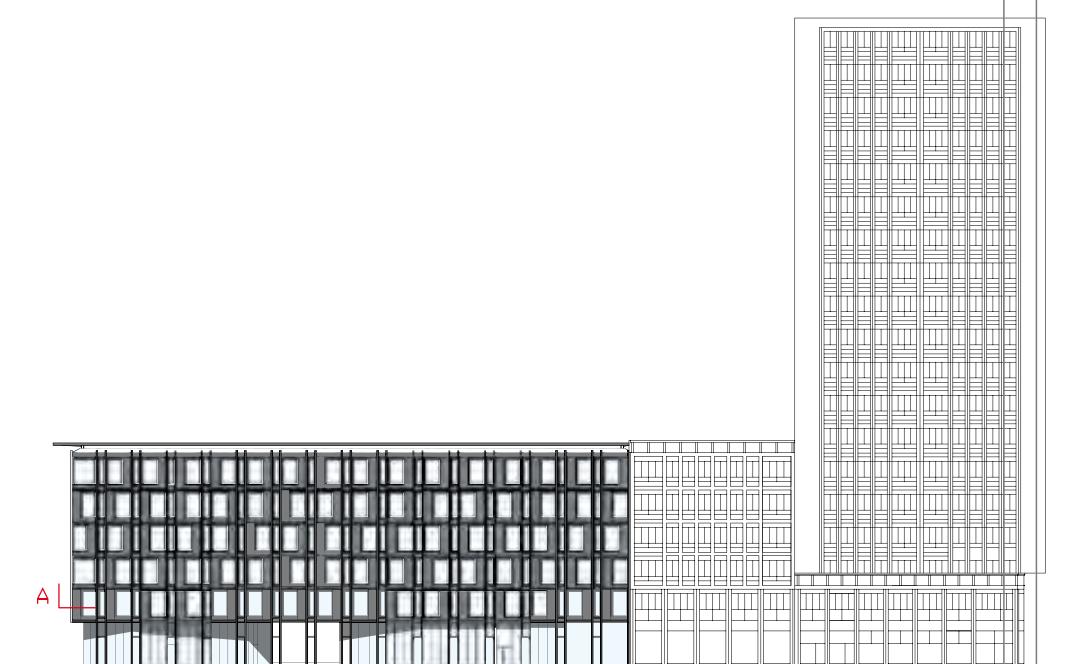

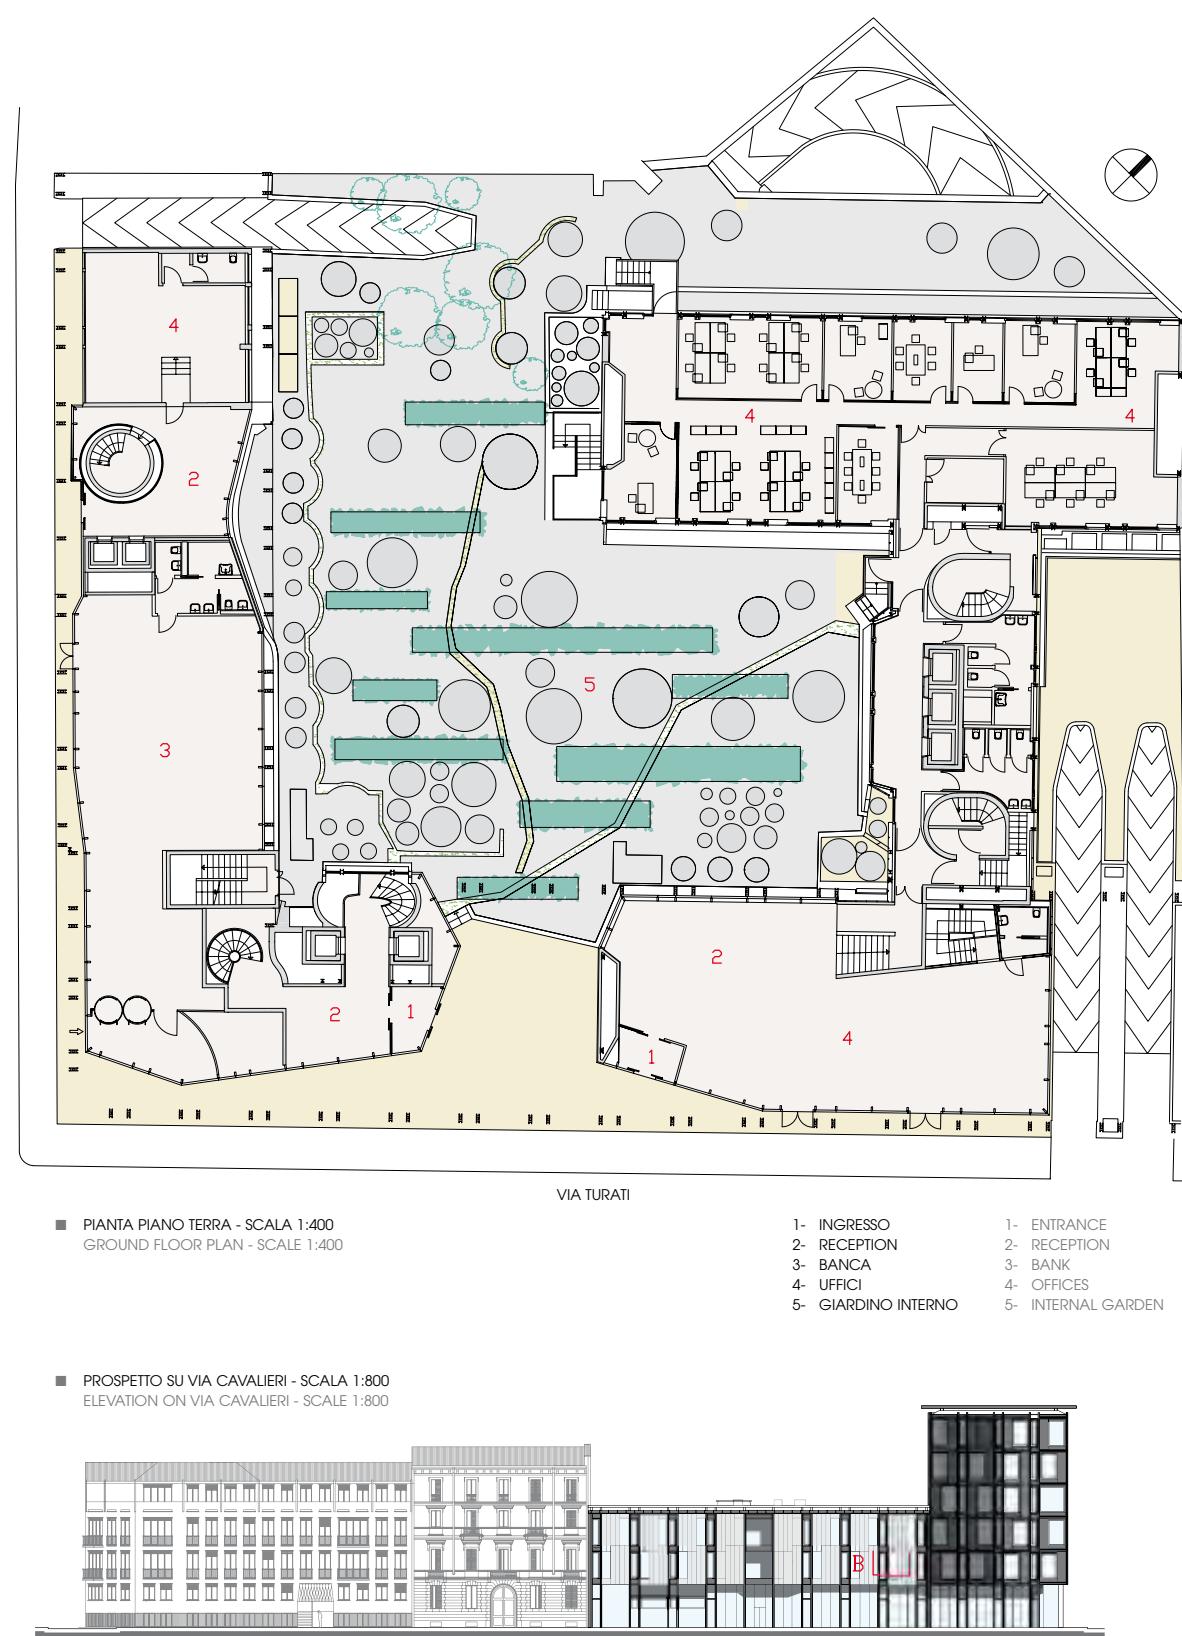

La riqualificazione operata da Park Associati dell'edificio direzionale La Serenissima a Milano, progettato nel 1962 per la società Campari dai fratelli Soncini e caratterizzato dal colore brunito delle strutture metalliche in facciata, ne ha recuperato l'immagine moderna, togliendone l'asprezza brutalista attraverso il minuzioso ridisegno delle parti della facciata. Nel corpo di fabbrica principale: una grande partizione alternata a una piccola ma con la grande a sua volta divisa in una parte tamponata e una vetrata tale da generare un secondo motivo che ammorbidisce un ritmo altrimenti troppo secco del tipo a-b-a-b. Nel corpo di fabbrica minore, un sistema leggermente più complesso, con rientranze che danno corpo al volume, ma che comunque gioca sugli stessi moduli e sotto-moduli di base. Con il risultato che l'edificio, pur conservando un aspetto unitario d'insieme, ha ritmo, misura e leggerezza.

Infine la collaborazione con Cino Zucchi. Il terzo eroe dell'High Touch a cui spetta il merito di aver introdotto all'interno dell'architettura italiana, attraverso un cauto ma costante sperimentalismo, forme e temi ripresi dalla più recente sperimentazione europea. Ma senza perdere mai l'attenzione all'architettura della città, intendendo questa non alla Aldo Rossi, e cioè un sistema di forme facilmente definibili dal punto di vista iconico, ma come un sistema di relazioni tali da garantire spazi

accattivanti, vivibili e comunque pensati a misura degli utenti anche nella scelta dei materiali. Salewa Headquarter, vista in questo senso, è un'opera chiave che racconta il punto di vista di Zucchi e, insieme, di Park.

La collaborazione con Zucchi non si ferma a questo edificio. Con ottimi risultati, come ci mostra per esempio la ristrutturazione dell'edificio direzionale Generali, la cui unica nota di demerito è, a parere di chi scrive, la grande vetrata giallo-verdognola sopra l'ingresso, una concessione alla moda dei vetri colorati diffusi in Europa a partire da un fortunato edificio di MVRDV ad Amsterdam.

Bravi come professionisti, come ci testimoniano le case ad Azzate - un'opera difficile in cui i tetti inclinati convivono con un'immagine moderna e allo stesso tempo rassicurante - Park mostra migliori potenzialità nei progetti più visionari. Tra questi vi è la Regnum Tower ad Istanbul. Tre sottili prismi arcuati delimitano un nucleo centrale vetrato. Ricorda vagamente un progetto di Manfredi Nicoletti le cui strutture furono inventate da Sergio Musmeci. Testimonianza di come il gruppo milanese sappia pescare dalla tradizione, riattualizzandola attraverso il filtro dell'High Touch.

Luigi Prestinenza Puglisi



The conversion by Park Associati of La Serenissima's Milan office, whose signature burnished metal facade was first built in 1962 for the Campari company (designed by the Soncini brothers), has given it a modern look, removing the raw Brutalist edge with a meticulous re-design of the facade partitioning. On the main building, large and small frames alternate, the large segment being further divided into a glazed and solid portion, creating a second motif. This pattern softens what would otherwise be an excessively harsh a-b-a-b sequence. Although based on the same succession of module and sub-module, the system on the facade of the smaller volume is slightly more complex, with recesses that lend substance to the volume. The overall result is a building whose original uncompromisingly uniform facade has now been given a more cadenced, lighter and measured appearance.

And so we come to Park's collaboration with Cino Zucchi, the third High Touch hero. Thanks to cautious but continual experimentation, Zucchi has enriched Italian architecture with forms and themes from cutting edge developments in Europe. Yet he has done this without ever losing sight of the architectural context of the Italian city. Not in the manner of Aldo Rossi, with a system of easily recognizable iconic forms; rather with a system of relations that give rise to attractive, liveable spaces whose

design and materials cater for the people who live in them. Seen from this point of view, the Salewa Headquarter is an exemplar of the Zucchi - and Park - approach.


Park's collaboration with Zucchi did not end with this building. They were also part of the excellent restructuring of the headquarters of insurance company Generali, whose only blemish - in the writer's opinion - is the huge yellow-green expanse of glazing above the entrance, a nod to the fashion for coloured glass that has spread throughout Europe in the wake of MVRDV's famous Amsterdam building.

Solid professionals - the residential and commercial complex of Azzate and its sloping roof testify to an ability to retain a reassuring aspect to their modernising stamp - Park has also notched up some much more visionary achievements. These include the Regnum Tower in Istanbul. The three slender sinuous prisms around a central glazed core are vaguely reminiscent of a project by Manfredi Nicoletti whose structures were designed by Sergio Musmeci. Their latest work testifies to the Milan group's ability to use the High Touch filter to sift through tradition and pick out features to include in their modern lexicon.

Luigi Prestinenza Puglisi



© Park Associati

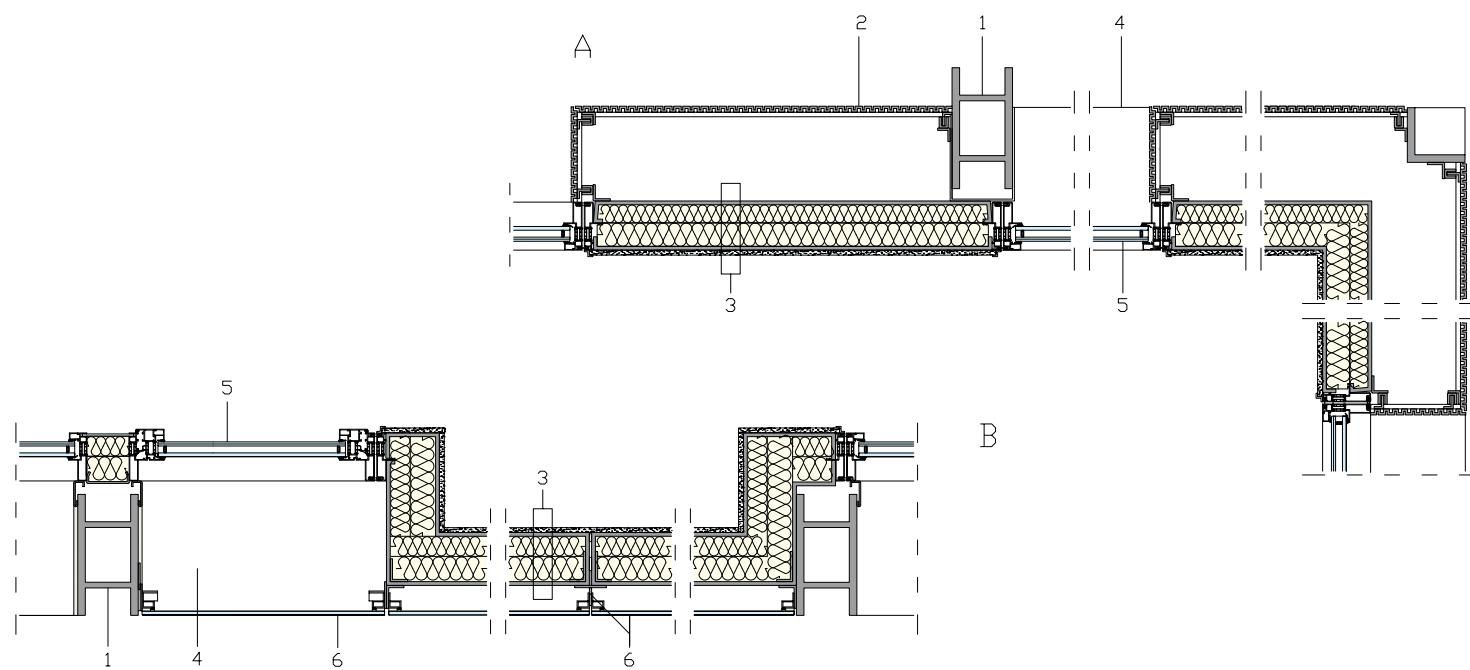


DETALLO A: SISTEMA DI FACCIA SU VIA TURATI
DETALLO B: SISTEMA DI FACCIA SU VIA CAVALIERI
SEZIONI ORIZZONTALI - SCALA 1:20


- 1- RESTORED AND REPAINTED EXISTING STRUCTURE
- 2- INTERFERENCE-COLOURED PRESS-BENT ANODIZED ALUMINUM CLADDING PANEL
- 3- CURTAIN WALL WITH 1/2" (13 MM) GYPSUM BOARD FINISH.
- 3/8" (10 MM) GALVANIZED SHEET STEEL SANDWICH PANELS, 4 3/4" (120 MM) RIGID INSULATION, 3/8" (10 MM) GALVANIZED SHEET STEEL
- 4- 3/8" (10 MM) THICK PAINTED ALUMINUM BENCH
- 5- FIXED DOUBLE-GLAZED ALUMINUM WINDOW WITH EXTERIOR 3/8" (10 MM) SELECTIVE STOPRAY VISION-60T ON CLEARVISION GLASS, 5/8" (16 MM) ARGON-FILLED AIR SPACE, AND INTERIOR AGC STRATOPHONE 66.2 GLASS
- 6- FINISH IN 5/16" (8 MM) AND 3/8" (10 MM) AGC LOW-IRON, BACK-FRITTED PLANIBEL CLEARVISION GLASS WITH ALUMINUM FRAMES, FASTENING SYSTEM WITH 1 3/4 X 2 3/8" (45X60 MM) AND 1 5/8 X 1" (40X25 MM) STEEL L-PROFILES AND BAR SUPPORT

DETAIL A: FAÇADE ON VIA TURATI
DETAIL B: FAÇADE ON VIA CAVALIERI
HORIZONTAL SECTIONS - SCALE 1:20

- 1- VORHANDENE RESTAURIERTE UND NEU GESTRICHENE STRUKTUR
- 2- PANEELE AUS VORGELÖCHTEM GEBOGENEM ANODISIERTEM INTERFERENZGEFÄRBTEM ALUMINIUM
- 3- UMFASSUNGSWAND MIT FINISH AUS GIPSkarton 13 MM, SANDWICH-PANEEL MIT VERZINKTEM STAHLBLECH 10 MM, DÄMPF PANNEEL 120 MM, VERZINKTES STAHLBLECH 10 MM
- 4- TISCH AUS LACKIERTEM ALUMINIUMBLECH 10 MM
- 5- FESTES FENSTER MIT ALUMINIUMRAHMEN UND ISOLIERGLAS MIT AUSSSENSCHEIBE AUS SELEKTIVEM GLAS STOPRAY VISION-60T AUF CLEARVISION 10 MM, ZWISCHENRAUM MIT ARGONGASFÜLLUNG 16 MM, INNENSCHIEBE STRATOPHONE 66.2 VON AGC
- 6- VERKLEIDUNG MIT RÜCKSEITIG EMAILLIERTER GLASSCHEIBE LOW IRON PLANIBEL CLEARVISION 8 UND 10 MM VON AGC MIT ALUMINIUMRAHMEN, BEFESTIGUNG MIT L-PROFILEN AUS STAHL 45X60 MM UND 40X25 MM UND STUTZSTREBEN

DETAIL A: FASSADE ZUR VIA TURATI
DETAIL B: FASSADE ZUR VIA CAVALIERI
VERTIKALSCHNitte - MASSSTAB 1:20

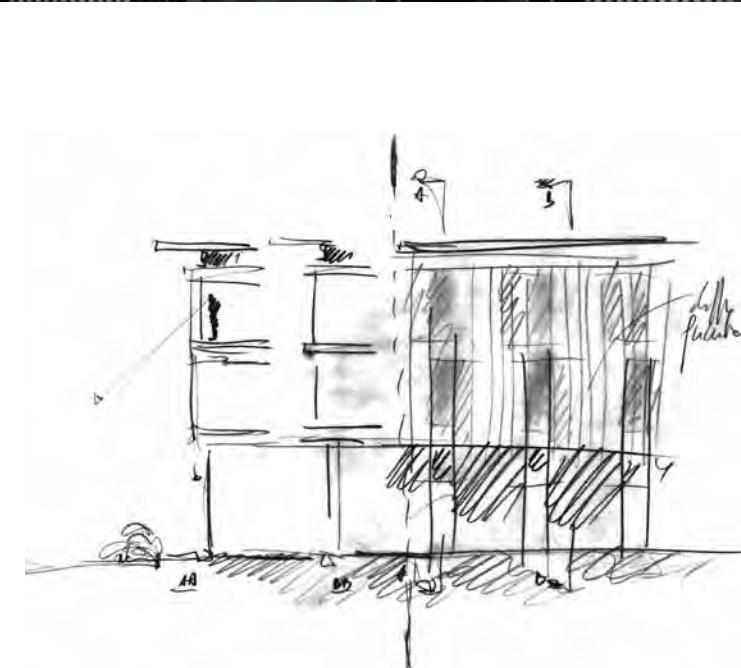

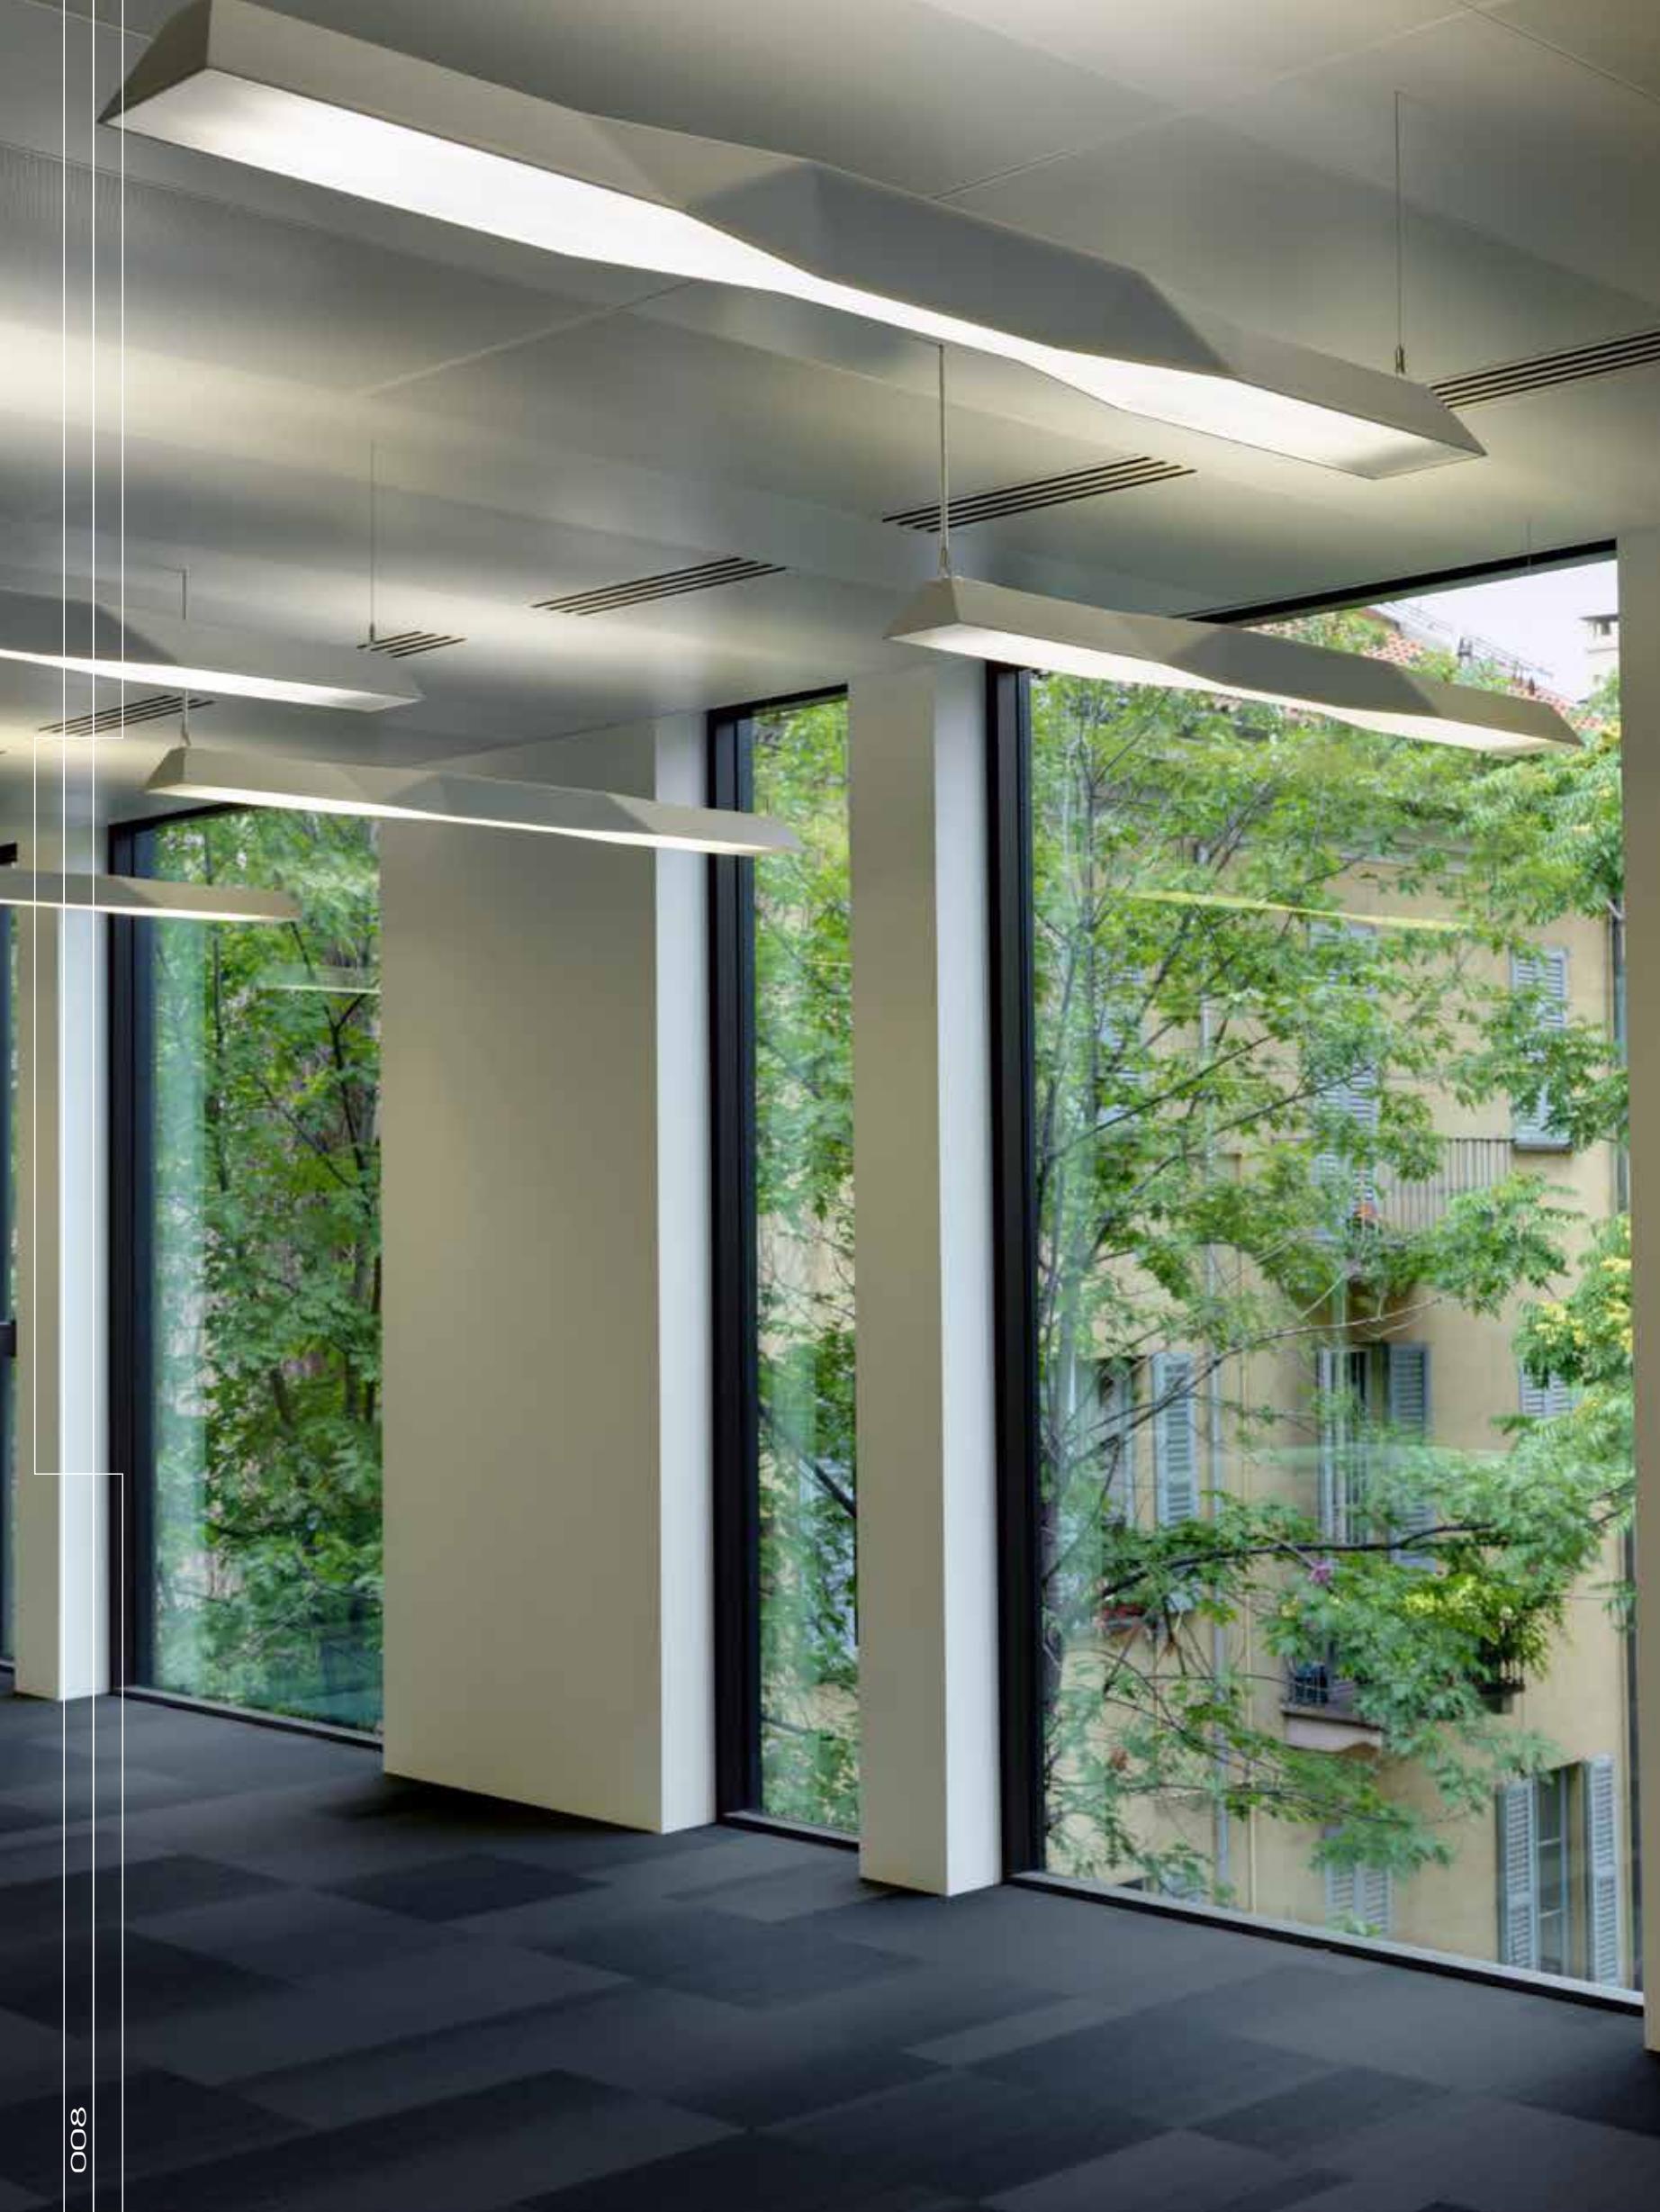

CREDITI / CREDITS

Location: Milano, Italy

Client: Morgan Stanley Sgr

Completion: 2012

Gross Floor Area: 8.000 m²

Construction Cost: 11.000.000 Euros

Architect: Park Associati,

Filippo Pagliani, Michele Rossi

Project Leader: Marco Panzeri

Project Team: Alice Cuteri, Andrea Dalpasso,

Marinella Ferrari, Stefano Lanotte,

Marco Siciliano, Paolo Ubaldi, Fabio Calciati

Site Supervision, Structural,

Mechanical and Electrical: General Planning

General Planning Design Team: Giovanni Bonini,

Loris Colombo, Walter Cola, Luca Dagrada,

Franco Pesci, Paolo Rossanigo,

Roberto Villa, Luigi Zinco

Artistic Site Supervision: Filippo Pagliani,

Michele Rossi, Marco Panzeri

Contractors

Main Contractor: Mangiavacchi Pedercini

Mechanical and Electrical: Furiga Impianti

Façades: CNS

Landscape: Cappellini

Consultants

Project Management:

ECHarris Built Asset Consultancy

Landscape Project: Marco Bay Architetto

LEED Certification: Habitech

Energy Certification: Azor Malpocher

Fire Prevention: General Planning

Health and Safety: Pro.Je.Co Engineering

Suppliers

Elevators: Kone

Facade Systems: Sapà

Metal Works: Ottone & Petterlin

Plasterboard and Raised Floor:

Coiver Contract, Gyproc

Carpet Flooring: Interface

Glass: AGC Glass Europe

Tiles Flooring: Marazzi

Lighting: Philips Lighting, Zumtobel

Ibla Dimmable Luminaire: Zumtobel,

designed by Park Associati

Ceilings: FURAL Systeme in Metall GmbH



Foto di / Photography by
Andrea Martiradonna
Images Courtesy Park Associati

Perfekte Metalldecken

Controsoffitti in metallo

Plafonds métalliques

Metalen plafonds

Metal ceilings

Metallofter

